

**LOCATION PLAN**  
1 : 4 000

**LEGEND**

**PLAN**  
FOR LEGEND PERTAINING TO PLAN VIEW SEE DRAWING T-1050-C-0001

**SECTION**


- BH-101-05 VERTICAL BOREHOLE - RECENT INVESTIGATION (NOTE 5)
- BH-401-05 BOREHOLE AND DYNAMIC PENETRATION TEST - RECENT INVESTIGATION (NOTE 5)
- BH-102-05 BOREHOLE WITH PIEZOMETER (OBSERVATION WELL) - RECENT INVESTIGATION (NOTE 5) (TERRATECH REPORT T-1050-A DATED MARCH 2005)
- W-001-04 VERTICAL BOREHOLE - PREVIOUS INVESTIGATION (TERRATECH REPORT T-1050-A DATED MARCH 2005)
- W-004-04 BOREHOLE WITH PIEZOMETER (OBSERVATION WELL) - PREVIOUS INVESTIGATION (TERRATECH REPORT T-1050-A DATED MARCH 2005)
- F-3 BOREHOLE DONE PREVIOUSLY BY OTHERS (LABORATOIRES D'EXPERTISES DE QUÉBEC LTÉE REPORT 4350-79 DATED DECEMBER 2004)
- 27 DISTANCE IN FRONT OF (↑) OR BEHIND (↓) THE ALIGNMENT OF THE SECTION (IN METERS)
- ROCK QUALITY DESIGNATION (%)
- SEISMIC REFLECTION SURVEY BY OTHERS (PROCEAN ENVIRONNEMENT / SNC-LAVALIN REPORT 502012 DATED 24 JANUARY 2006)

- NOTES**
- For notes pertaining to plan view see drawing T-1050-C-0001.
  - All elevations are in meters and refer to geodetic datum.
  - The stratigraphy shown on the sections has been simplified. For a more precise stratigraphy description, refer to the boring logs.
  - Data concerning the various strata have been obtained at borehole locations only. The soil stratigraphy between boreholes may vary from that shown.
  - "Recent investigation" refers to exploration works carried out during the period of 8 February to 15 April, 2005 (report T-1050-B of May 2005) and during the period of 30 September to 4 November, 2005 (this report).
  - This drawing is to be read in conjunction with the accompanying report.

**SOIL STRATIGRAPHY**

|                     |              |
|---------------------|--------------|
| FILL                | ORGANIC SOIL |
| CLAY                | SILT         |
| SAND                | GRAVEL       |
| COBBLES OR BOULDERS | BEDROCK      |

**SPECIAL NOTE**  
The geology shown on the sections does not represent the exact reality. It is based on a geological interpretation and therefore any extrapolation and interpolation should be considered with great caution.  
The information provided here is not intended for construction purposes.

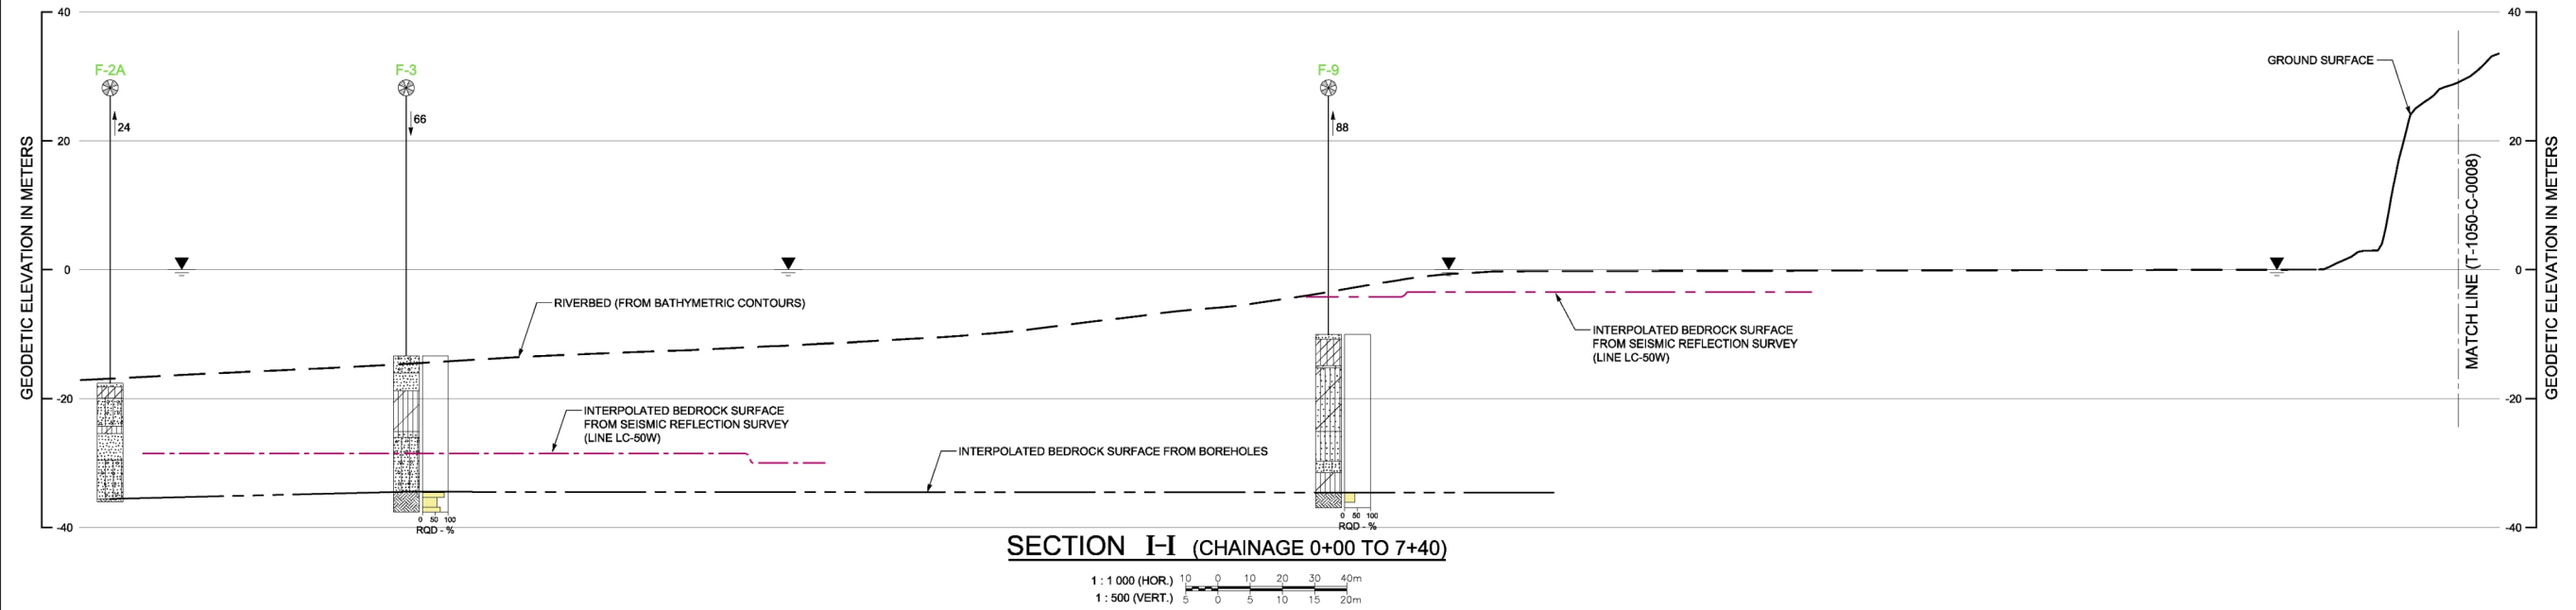

**SECTION I-I (CHAINAGE 0+00 TO 7+40)**  
1 : 1 000 (HOR.)  
1 : 500 (VERT.)

LAST SAVE: 2006/05/03 - 8:28am  
PATH: Z:\044238\4C\1-1050-C-1-86.dwg

| <p>ISSUE REGISTER</p> <table border="1"> <thead> <tr> <th>ISSUE No</th> <th>REV.</th> <th>DATE (Y/M/D)</th> <th>PURPOSE OF ISSUE</th> </tr> </thead> <tbody> <tr> <td>1</td> <td>0</td> <td>2006-05-01</td> <td>ISSUED WITH FINAL REPORT T-1050-C</td> </tr> </tbody> </table> |  | ISSUE No     | REV.                              | DATE (Y/M/D) | PURPOSE OF ISSUE     | 1   | 0  | 2006-05-01   | ISSUED WITH FINAL REPORT T-1050-C | <p>ISSUE REGISTER</p> <table border="1"> <thead> <tr> <th>ISSUE No</th> <th>REV.</th> <th>DATE (Y/M/D)</th> <th>PURPOSE OF ISSUE</th> </tr> </thead> <tbody> </tbody> </table> |  | ISSUE No | REV. | DATE (Y/M/D) | PURPOSE OF ISSUE | <p>REVISION REGISTER</p> <table border="1"> <thead> <tr> <th>No</th> <th>REVISION DESCRIPTION</th> <th>DATE (Y/M/D)</th> <th>**</th> <th>No</th> <th>REVISION DESCRIPTION</th> <th>DATE (Y/M/D)</th> <th>**</th> </tr> </thead> <tbody> </tbody> </table> |  | No | REVISION DESCRIPTION | DATE (Y/M/D) | ** | No | REVISION DESCRIPTION | DATE (Y/M/D) | ** | <p>REVISION REGISTER</p> <table border="1"> <thead> <tr> <th>No</th> <th>REVISION DESCRIPTION</th> <th>DATE (Y/M/D)</th> <th>**</th> </tr> </thead> <tbody> </tbody> </table> |  | No | REVISION DESCRIPTION | DATE (Y/M/D) | ** | <p>REFERENCE DRAWINGS</p> <table border="1"> <thead> <tr> <th>No</th> <th>DESCRIPTION</th> </tr> </thead> <tbody> <tr> <td>1</td> <td>SNC-LAVALIN RABASKA - LNG RECEIVING TERMINAL OVERALL SITE PLAN DRAWING: 016267-0000-41-D2-0001, REV. A DATED: 2005-05-31</td> </tr> </tbody> </table> |  | No | DESCRIPTION | 1 | SNC-LAVALIN RABASKA - LNG RECEIVING TERMINAL OVERALL SITE PLAN DRAWING: 016267-0000-41-D2-0001, REV. A DATED: 2005-05-31 | <p>PROFESSIONAL SEAL</p> <p><b>Terratech</b> Division of SNC-LAVALIN Environment Inc. </p> <p><b>Rabaska</b> RABASKA LNG IMPORT TERMINAL QUEBEC, CANADA</p> |  | <p>CLIENT</p> <p>RABASKA - LNG RECEIVING TERMINAL LEVIS/BEAUMONT QUEBEC</p> |  |
|---|
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| <p>PREPARATION: R. Bousquet, M.A.Sc., Eng.</p>   |  |              |                                   |              |                      | <p>APPROVAL: H. Madjar, M.A.Sc., Eng.</p> |    | <p>PROJECT: RABASKA - LNG RECEIVING TERMINAL LEVIS/BEAUMONT QUEBEC</p>     |                                   |  | <p>DRAWN: R. Anderson</p>  |  |              |                                   |              |                      | <p>PROJECT ENGINEERING MANAGER</p>        |    | <p>TITLE: SECTION I-I LOCATION PLAN AND STRATIGRAPHIC SECTION (1 OF 2)</p> |                                   |  | <p>CHECKED: R. Bousquet, M.A.Sc., Eng.</p>   |  |              |                                   |              |                      | <p>CLIENT</p>                             |    | <p>PROJECT No: T-1050-C</p>  |                                   |  | <p>DATE: 2006-04-28</p>  |  |              |                                   |              |                      | <p>SCALE: AS SHOWN</p>                    |    | <p>SUBDIVISION: 0000</p>   |                                   |  | <p>SCALE: AS SHOWN</p>   |  |              |                                   |              |                      | <p>SCALE: AS SHOWN</p>                    |    | <p>SUBJECT: 4G/DD</p>  |                                   |  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